

STUDY AREA PERSPECTIVE





REFURBISH
REFURBISH
PROJECT LOCATION:

REFURBISHMENT OF TSU MAIN CAMPUS LIBRARY

CBA BUILDING, MAIN CAMPUS

MS. CYNTHIA M. BOG

REQUESTING OFFICE:



AR. ARLEN M. GUIEB
PLANNING UNIT HEAD, FDMO

UIEB AR. CHERRY L. FABIANES
DIRECTOR, FOMO

DR. GR

DR. GRACE N. ROSETE DR. ABNOLI

APPROVED:

SHEET CONTENTS:

SHEET NO:

A-01

PAGE NO:

DATE:

SHEET NO:

1/21



READING AREA PERSPECTIVE





REFURBISHMENT OF TSU MAIN CAMPUS LIBRARY

CBA BUILDING, MAIN CAMPUS


REQUESTING OFFICE: Cleir

MS. CYNTHIA M. BOGNOT AR. MARK AN HOUR PUNZALAN

AR. CHERRY L. FABIANES

DR. ARNOLD E. VELASCO

AS SHOWN PAGE NO: 2/21

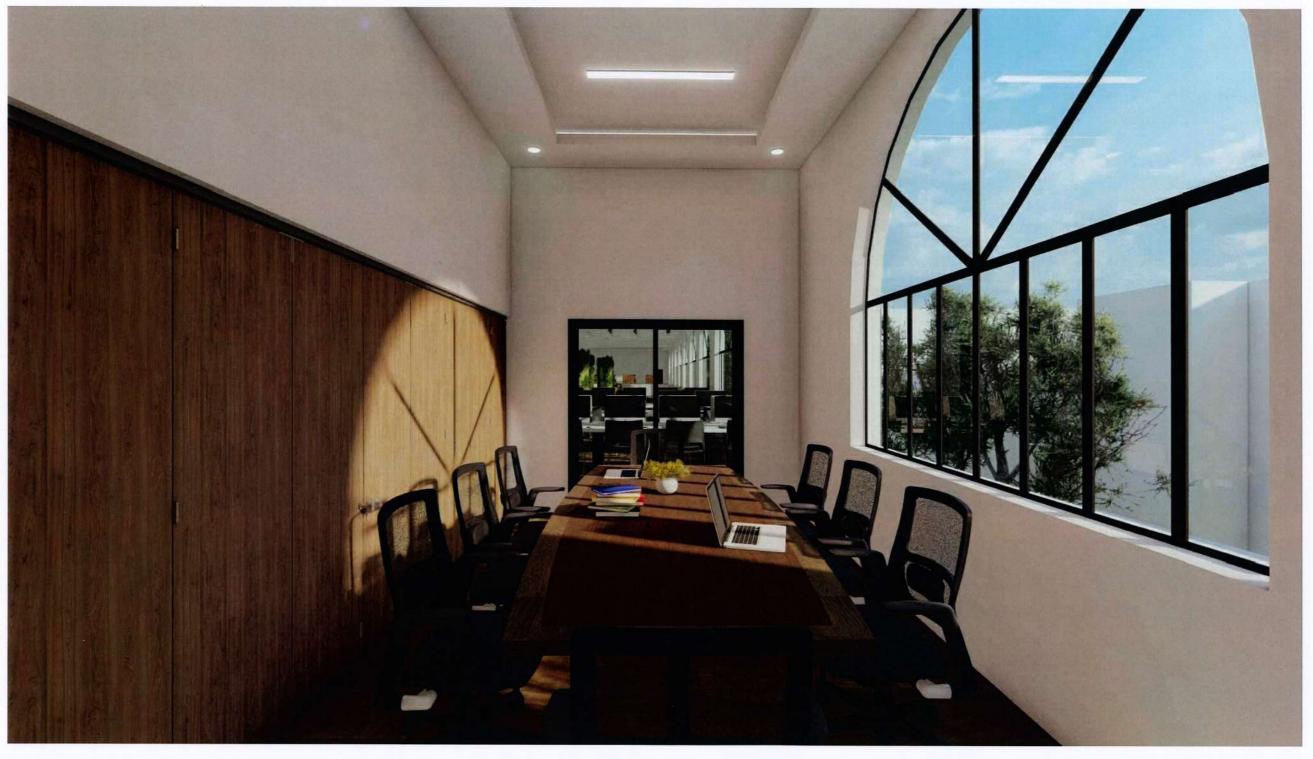

DISCUSSION ROOM PERSPECTIVE





REFURBISHMENT OF TSU MAIN CAMPUS LIBRARY

REQUESTING OFFICE: Cour


MS. CYNTHIA M. BOGNOT AR. MARK ANTI-SAR PUNZALAN LIBRARY DIRECTOR

AR. CHERRY L. FABIANES
DIRECTOR, FDMO


DR. GRACE N. ROSETE

VP ADMIN AND FINANCE

A-03 DR. ARNOLD E. VELASCO AS SHOWN 3/21

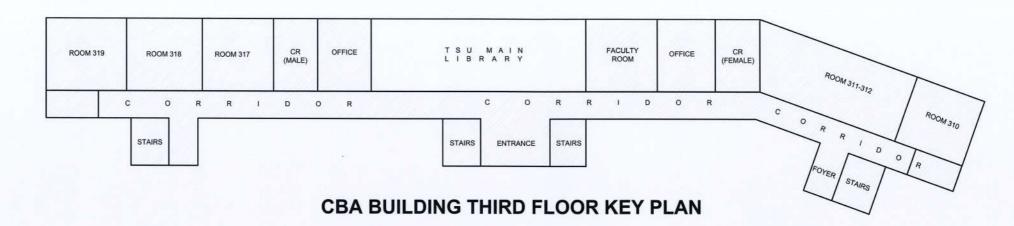

- ALL EXISTING DRYWALL PARTITIONS, CEILING, FLOOR TILES, DOORS AND WINDOWS WILL BE DEMOLISHED AND REPLACED.
- DOORS AND WINDOWS ALONG HALLWAY, AFFECTED BY THE DEMOLITION WILL BE INCLUDED IN MASONRY AND PLASTERING.

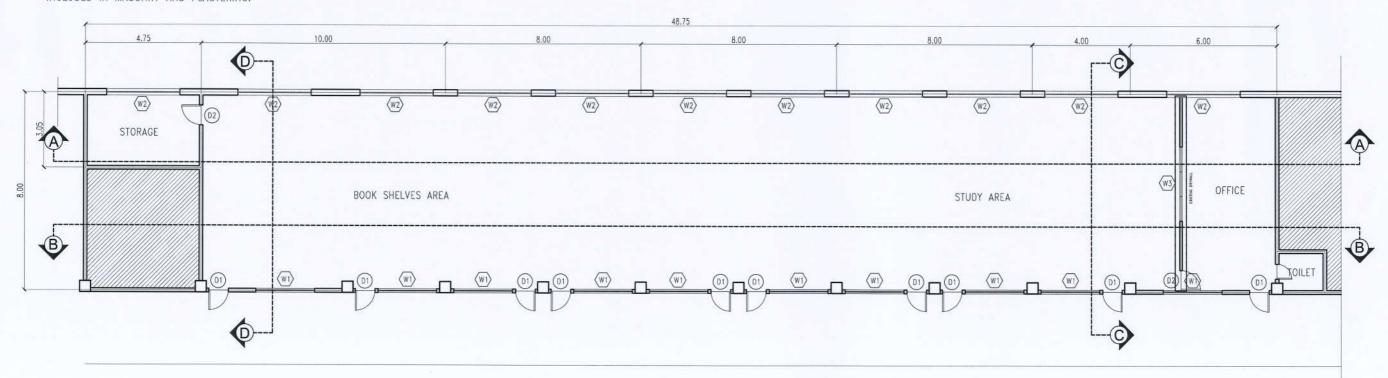

MAIN LIBRARY EXISTING FLOOR PLAN

SCALE 1:150 MTS.

REQUESTING OFFICE:





REFURBISHMENT OF TSU MAIN CAMPUS LIBRARY

CBA BUILDING, MAIN CAMPUS

Cow

MS. CYNTHIA M. BOGNOT
LIBRARY DIRECTOR

AR. MARK ANTHON PUNZALAN
ARHITECT. FOMO

AR. ARLEN M. GUIEB


AR. CHERRY L. FABIANES
DIRECTOR, FDM0


DR. GRACE N. ROSETE


VP ADMIN AND FINANCE


DR. ARNOLD E. VELASCO


A-04 AS SHOWN PAGE NO: 4/21

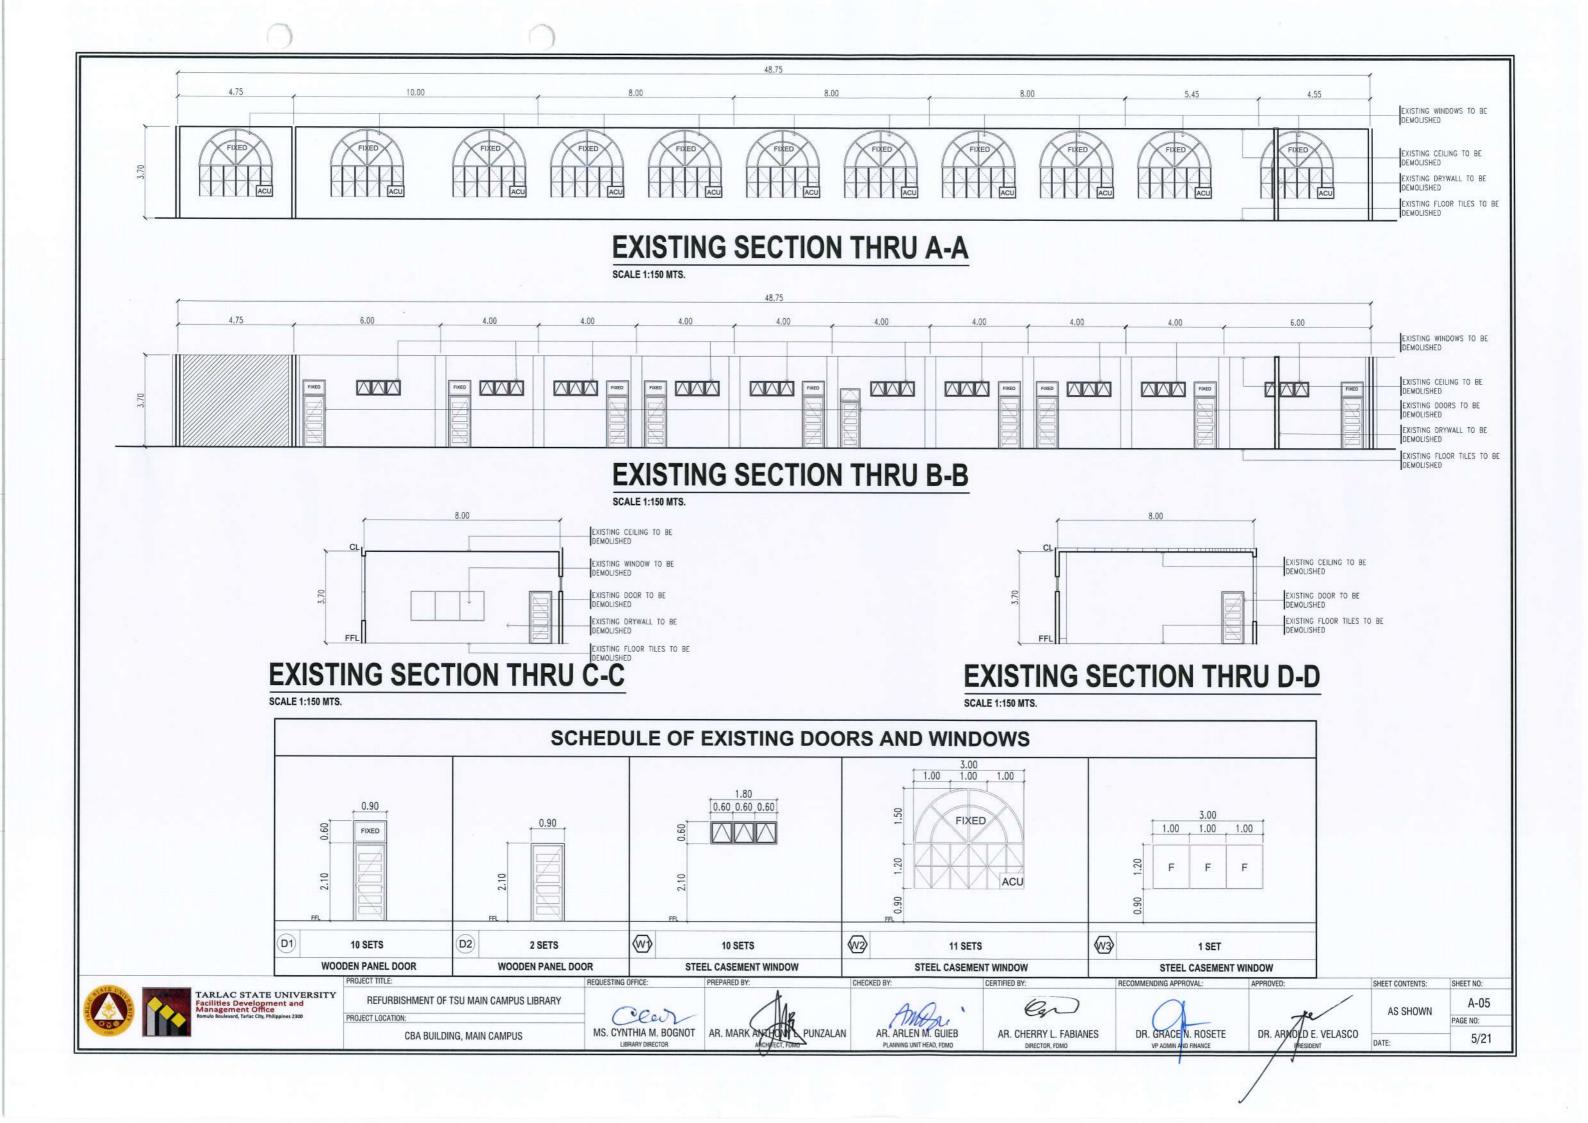


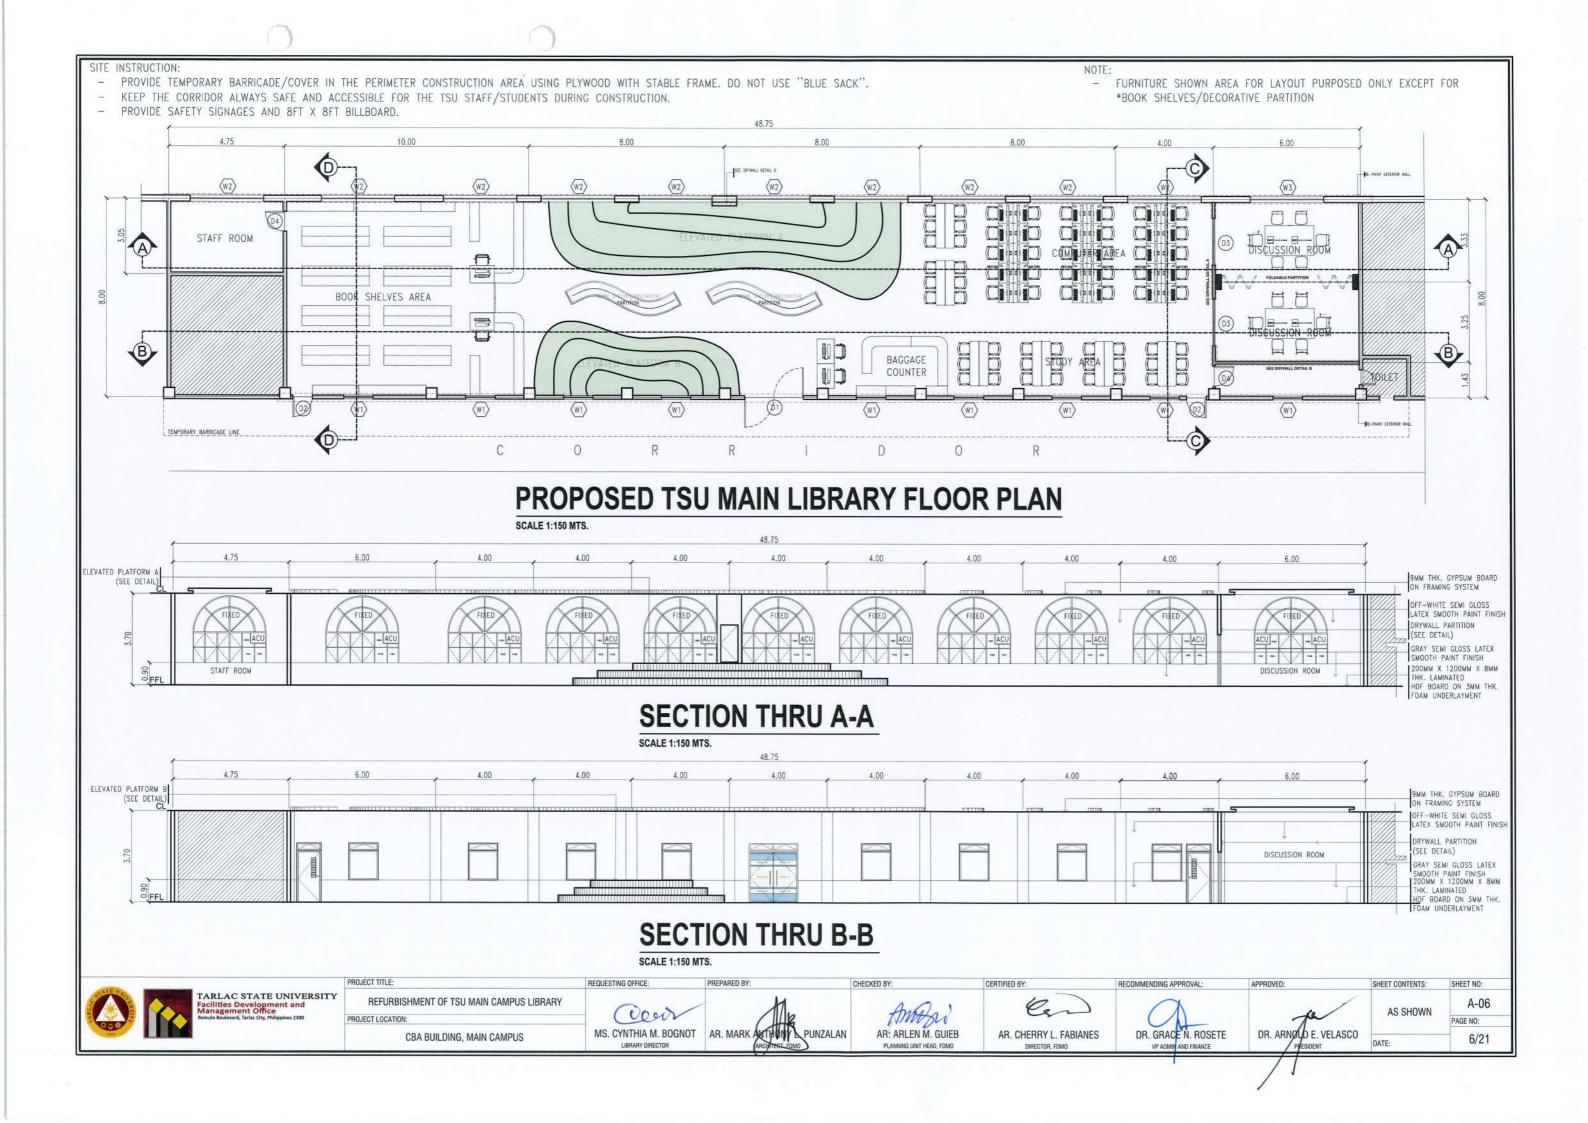


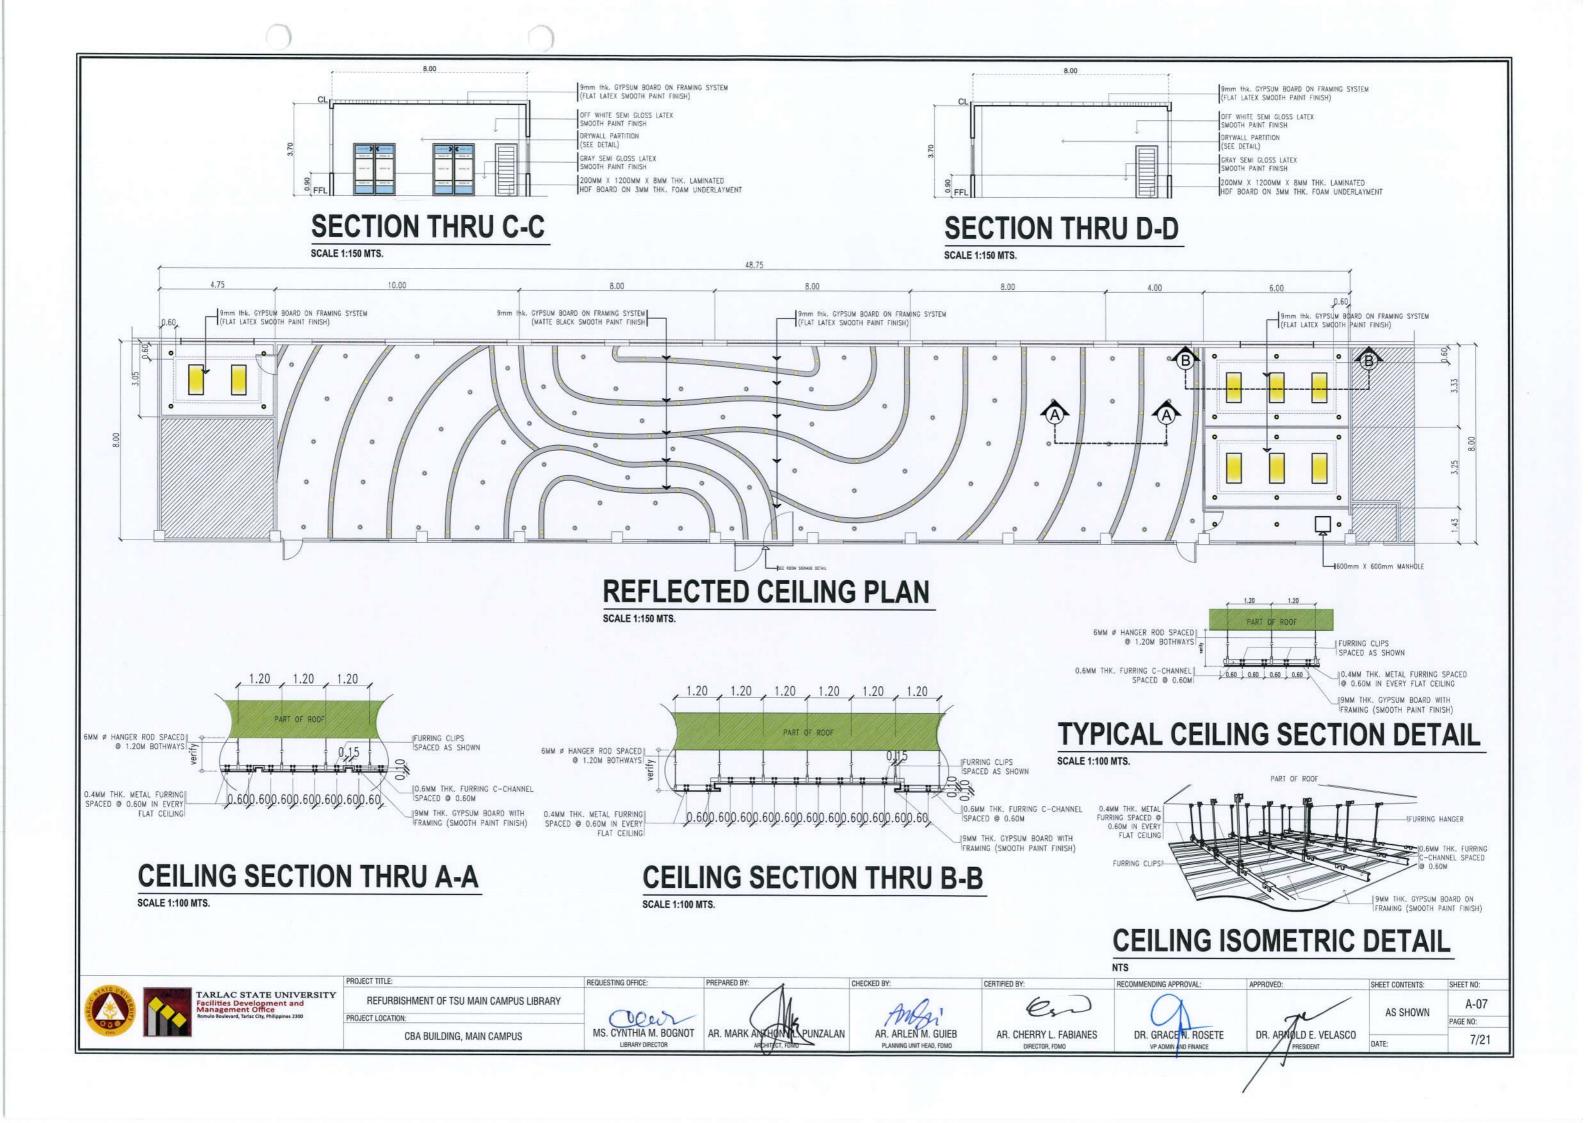

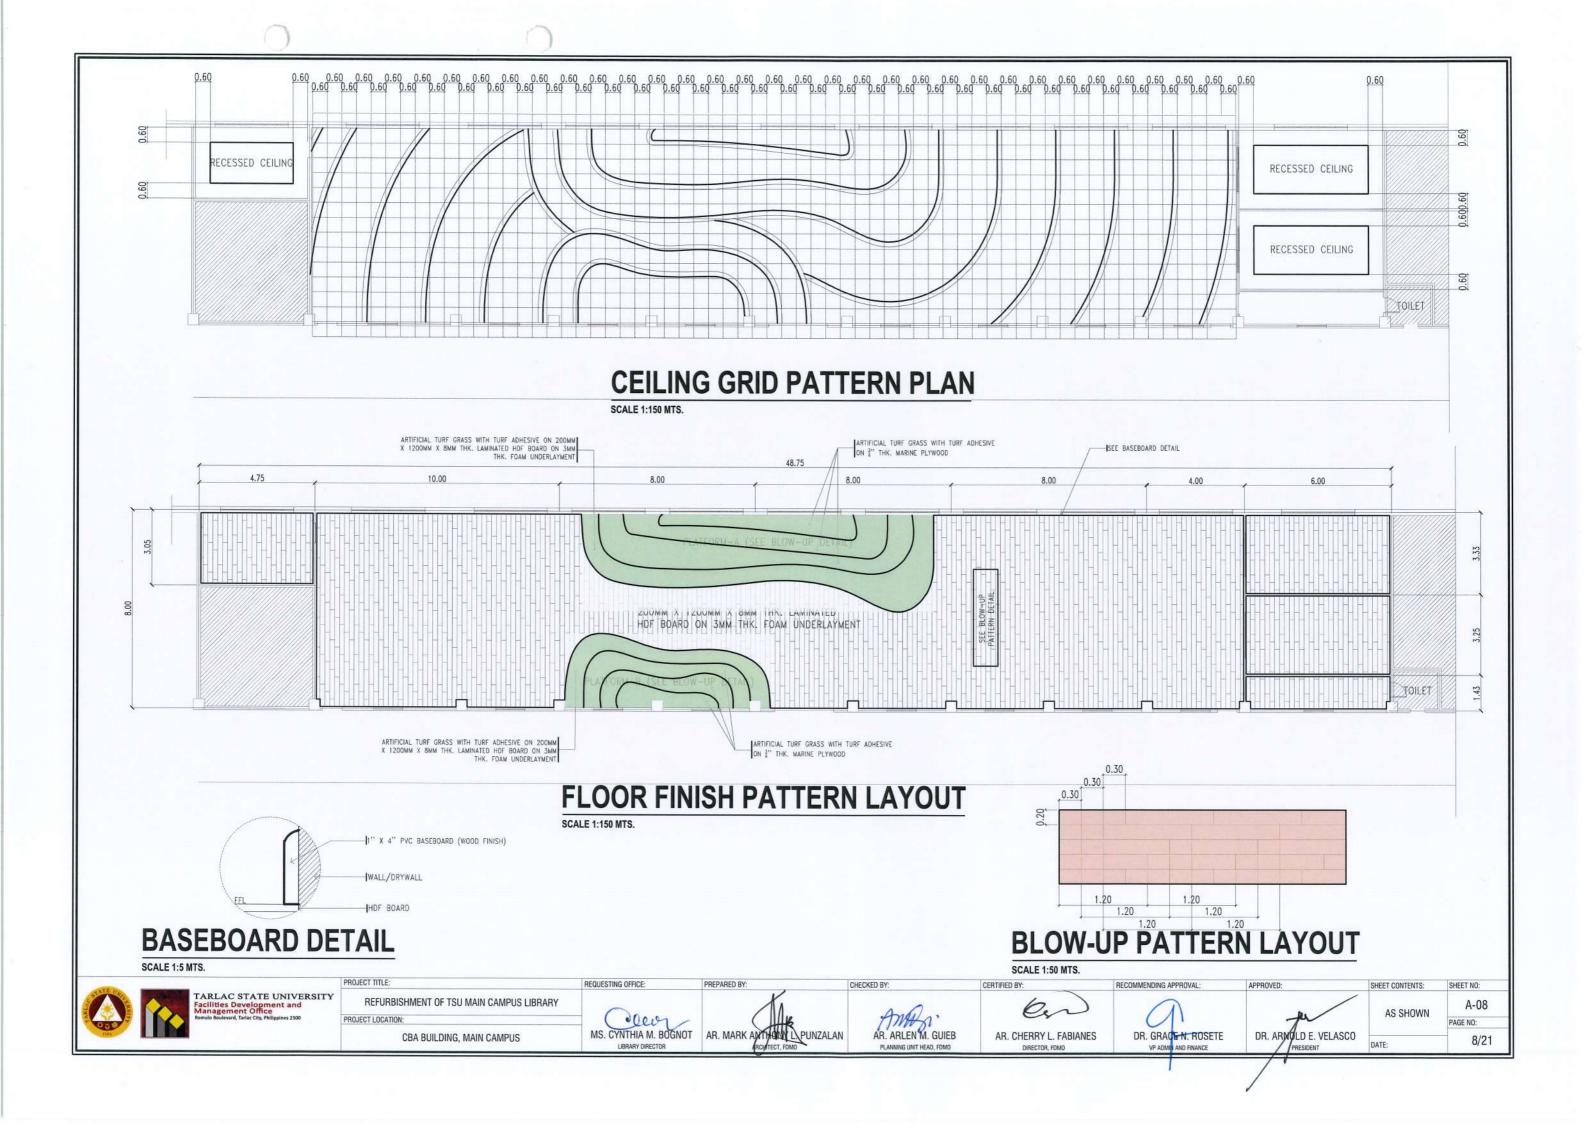

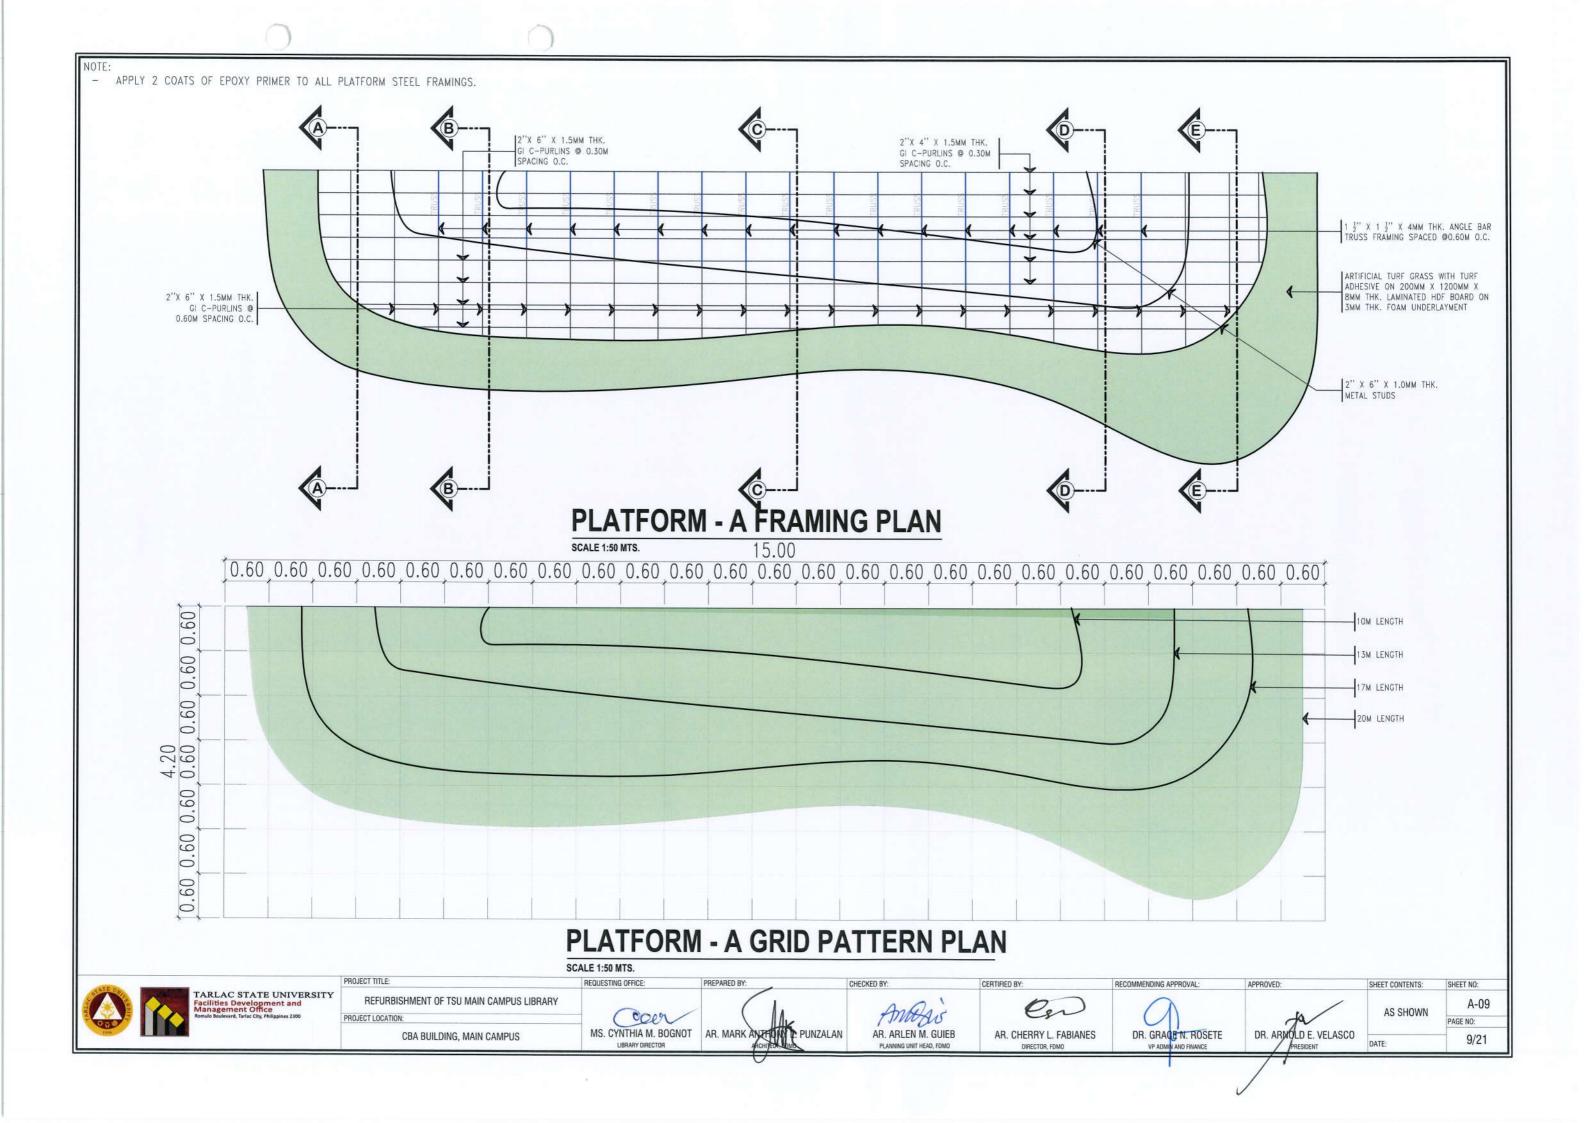


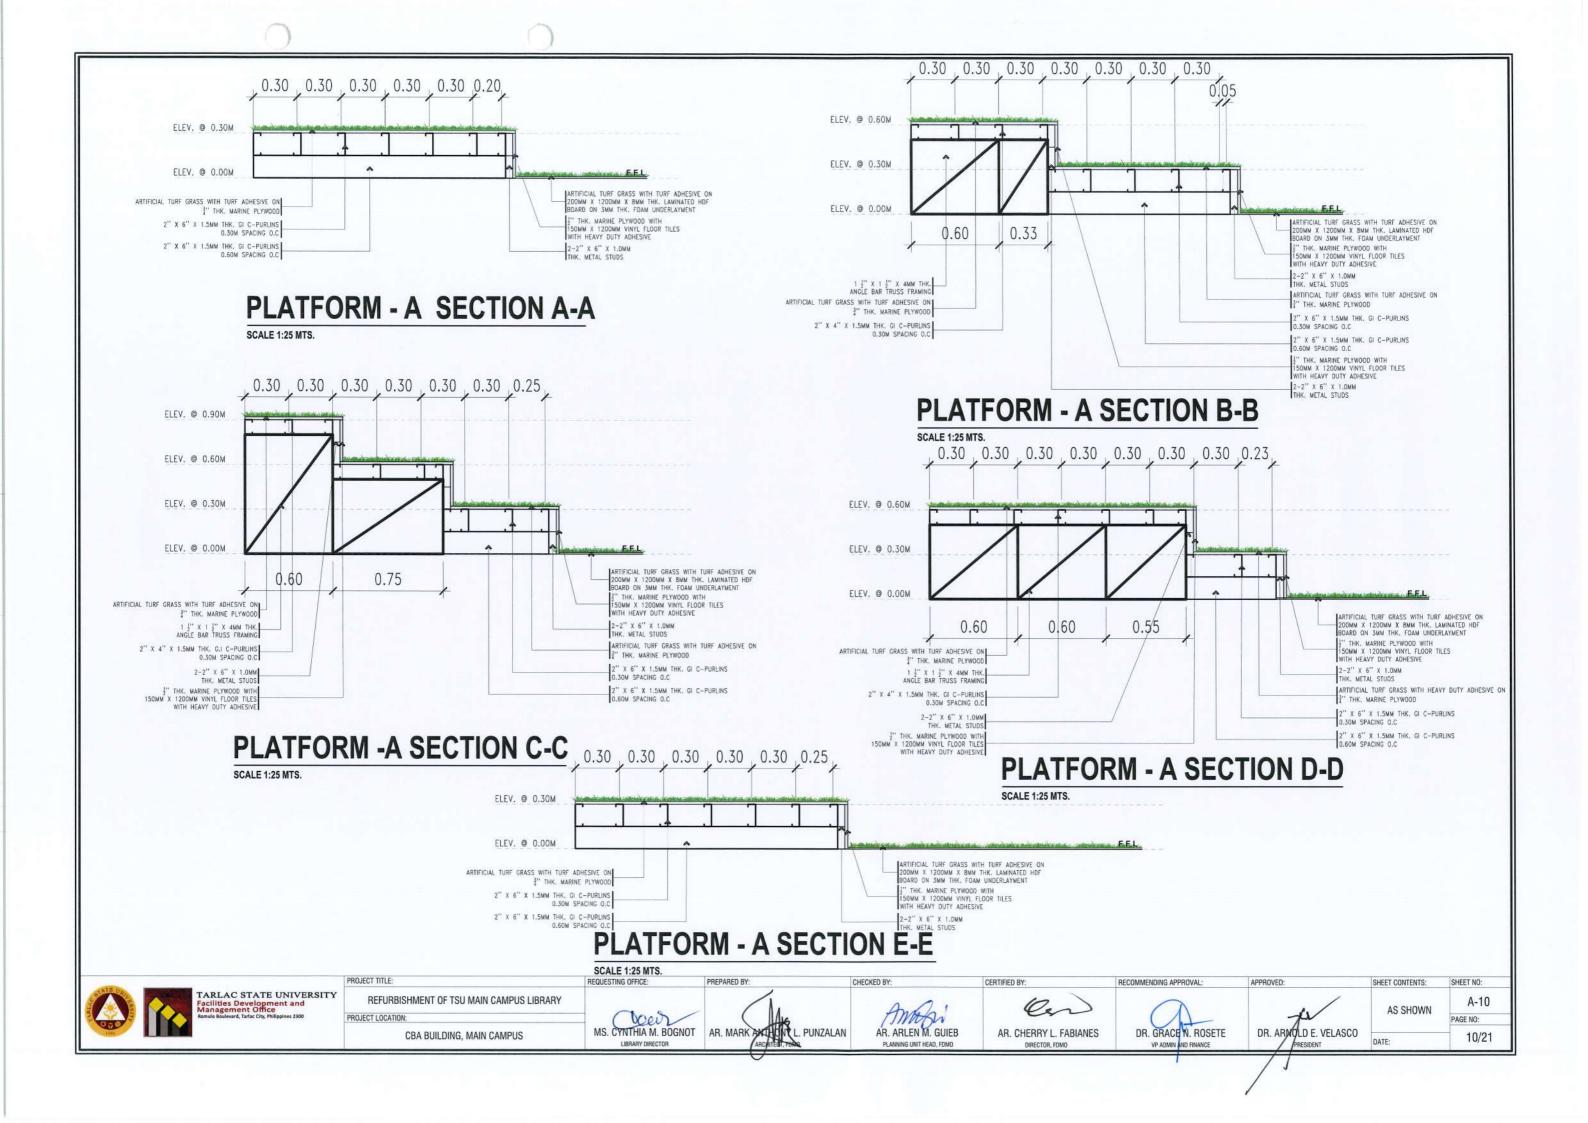

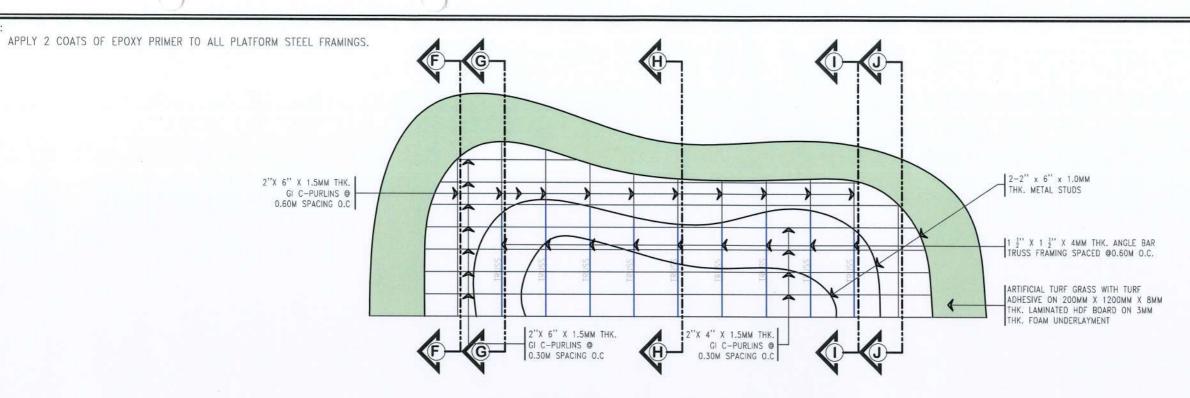

PLATFORM - B FRAMING PLAN

SCALE 1:50 MTS.

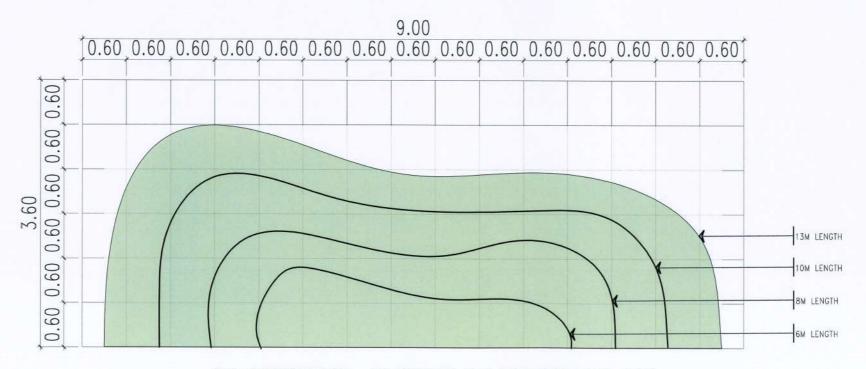

PLATFORM - B GRID PATTERN PLAN

SCALE 1:50 MTS.

REQUESTING OFFICE:





PROJECT TITLE:

REFURBISHMENT OF TSU MAIN CAMPUS LIBRARY CBA BUILDING, MAIN CAMPUS



MS. CYNTHIA M. BOGNOT AR. MARK ANTHONY PUNZALAN ROUTECT, FOMO

AR. ARLEN M. GUIEB PLANNING UNIT HEAD, FDMO

AR. CHERRY L. FABIANES


DR. GRACE N. ROSETE

VP ADMIN AND FINANCE


RECOMMENDING APPROVAL

DR. ARNOLD E. VELASCO

A-11 AS SHOWN PAGE NO: 11/21

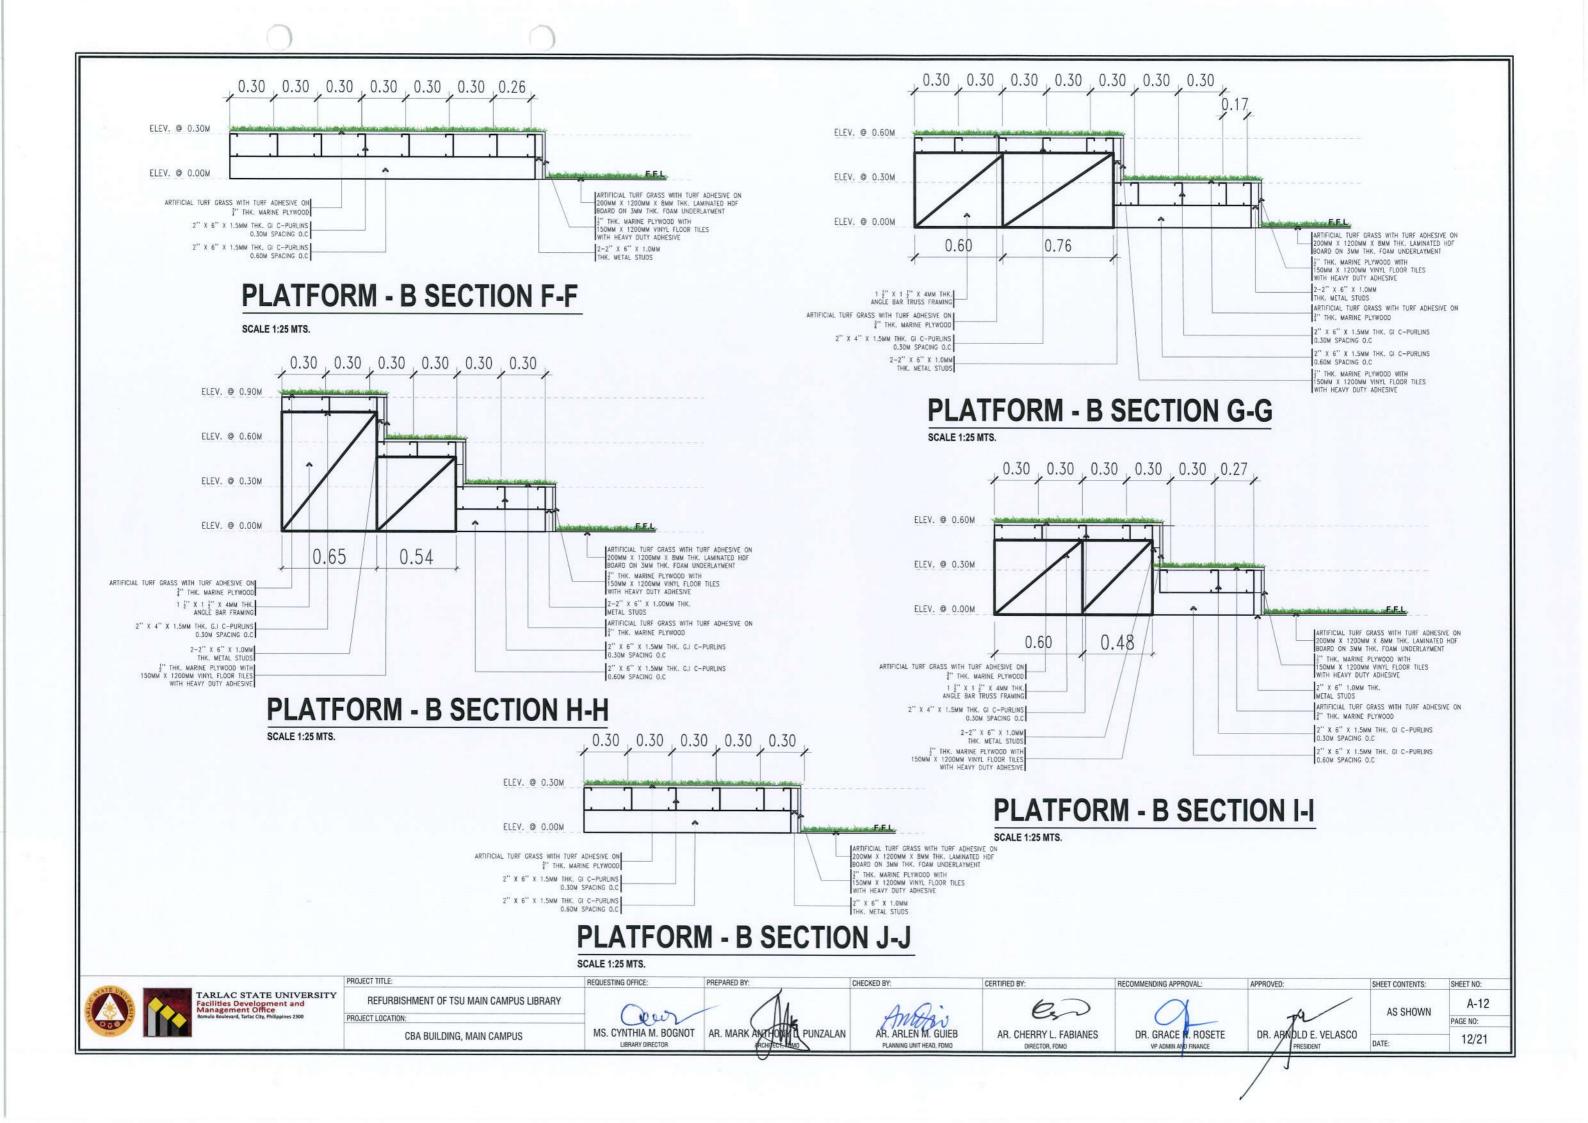


SCHEDULE OF DOORS AND WINDOWS

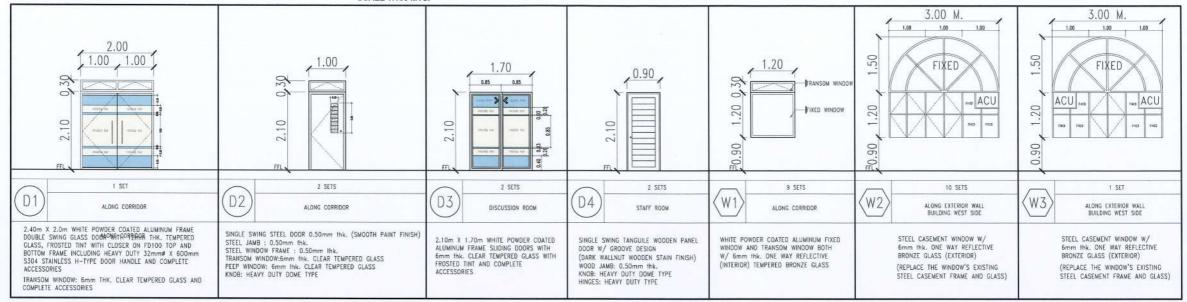


FOR OPENINGS:

- VERIFY ON SITE ALL THE EXISTING SIZES OF DOORS, WINDOWS AND OPENINGS
- ENCLOSE ALL OPENINGS (DOORS, WINDOWS, ACU, ETC.) REQUIRED BY THE PROPOSED PLAN.


INTERIOR WALL, CEILING AND COLUMNS SHALL REPAINTED. NEWLY PLASTERED AREA OF EXTERIOR WALLS "REPAIRED" SHALL BE REPAINTED WITH THE SAME EXISTING PAINT COLOR.

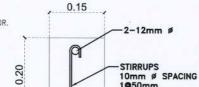


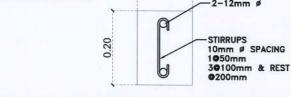


TYPICAL LINTEL BEAM SECTION

SCALE 1:20 MTS.

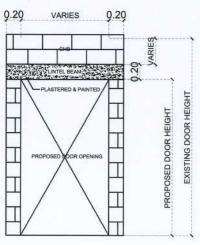

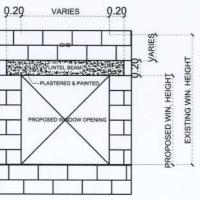

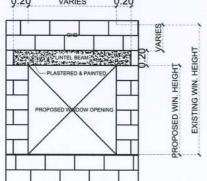

TYPICAL DOORS & WINDOWS

LINTEL BEAM DETAIL



PROJECT TITLE:				
REFURBISHMENT OF TSU MAIN CAMPUS LIBRARY				
PROJECT LOCATION:				


CBA BUILDING, MAIN CAMPUS

REQUESTING OFFICE: PREPARED BY ocen

Amori AR, ARLEN M. GUIEB PLANNING UNIT HEAD, FDMO

CHECKED BY:

FOLDABLE PARTITION DETAIL

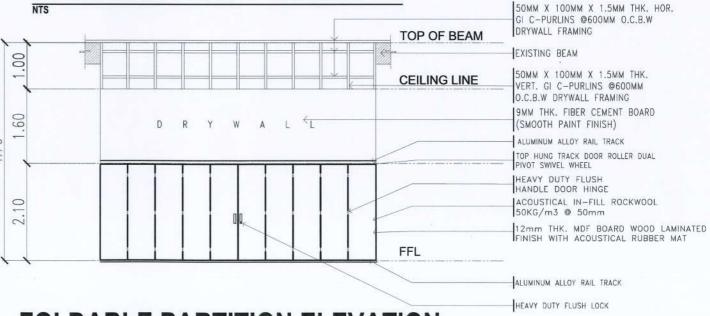

- JOHN THK, FICEM BOARD (SMOOTH PAINT FINISH)

JALUMINUM ALLOY RAIL TRACK TOP HUNG TRACK DOOR ROLLER DUAL PIVOT SWIYEL WHEEL

-UPPER AND LOWER SEALS

ALUMINUM ALLOY PANEL TRIM

ROCKWOOL ACOUSTICAL INFILL

-12" X 4" X 1.5MM THK, C-PURLINS DRYWALL FRAME

12mm THK. MDF BOARD WOOD LAMINATED FINISH WITH ACOUSTICAL RUBBER MAT NEEDLE ROLLER BEARING DURABLE

FOLDABLE PARTITION ELEVATION

SCALE 1:80 MTS.








MS. CYNTHIA M. BOGNOT

AR. MARK ANALON . PUNZALAN

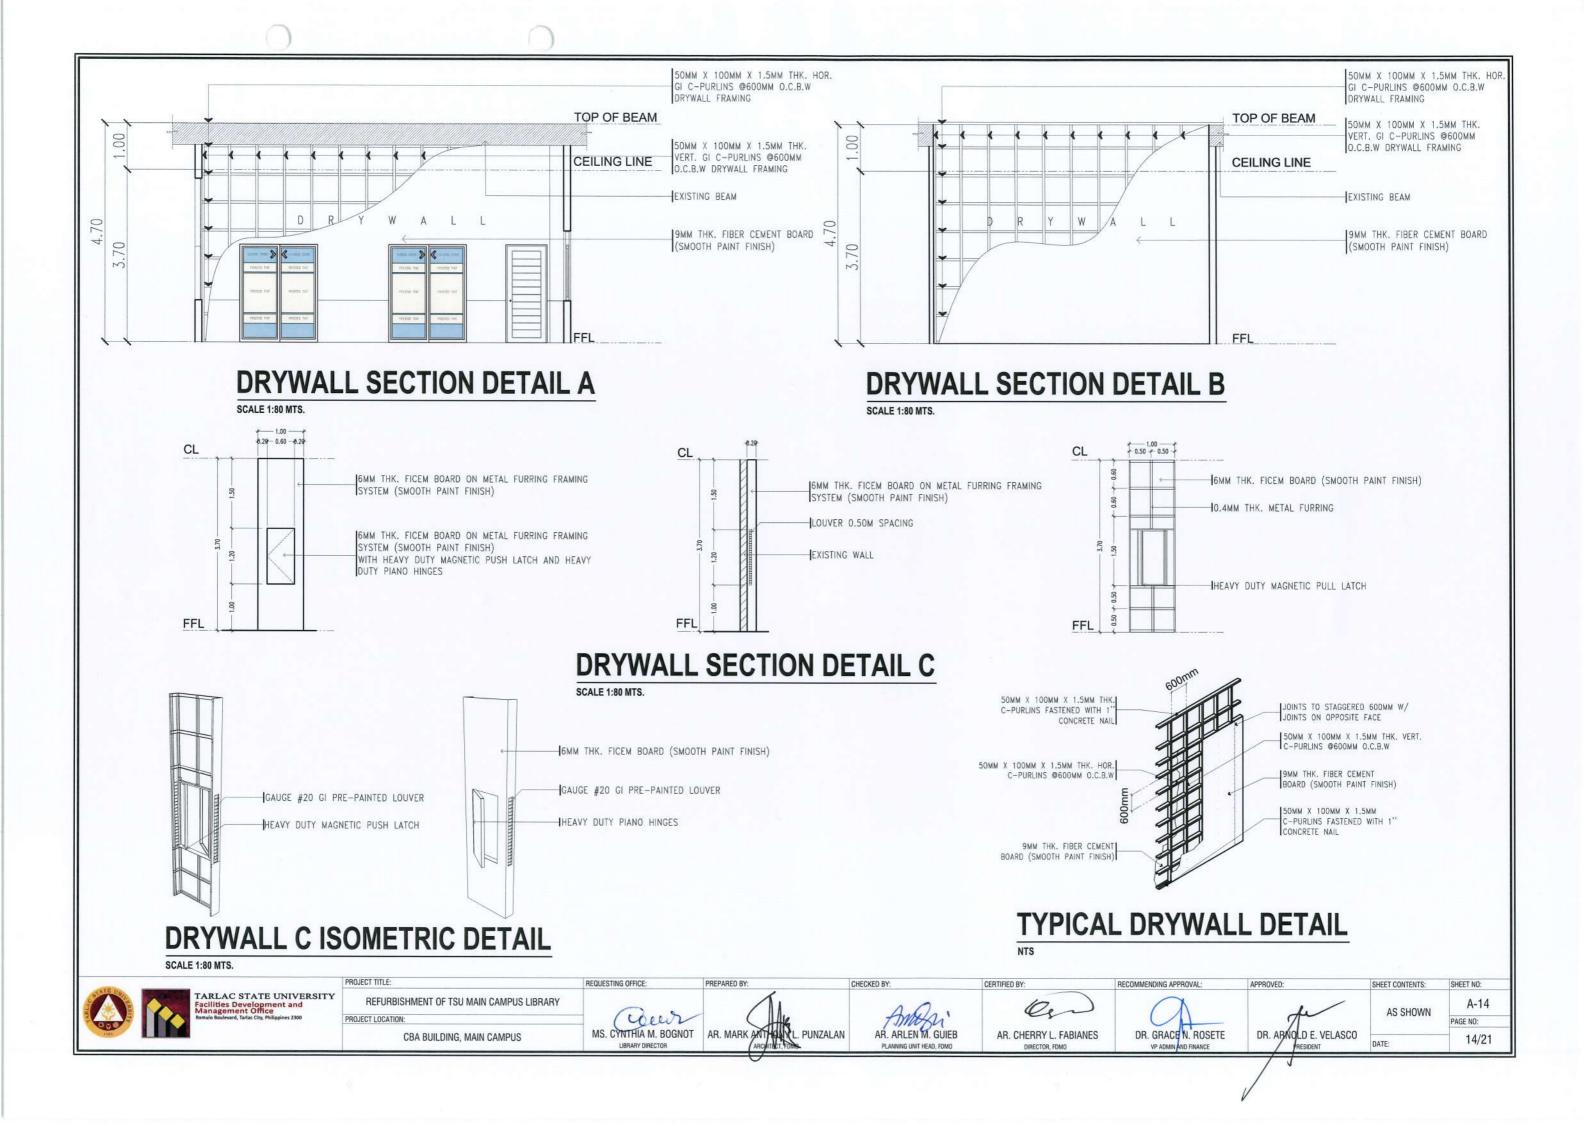


NOTE:

- THE FONT STYLE, FONT SIZE, TEXT CONTEXT SHALL BE FOR APPROVAL.
- LOCATION OF SIGNAGE SHALL BE VERIFY ON ACTUAL.



ROOM SIGNAGE DETAIL

SCALE 1:30MTS

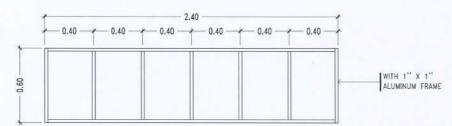




ROOM SIGNAGE ISOMETRIC

ROOM SIGNAGE FRAMING

SCALE 1:30MTS

 APPLY 2 COATS OF EPOXY PRIMER ON ALL STEEL FRAME MEMBERS AT LEAST 2 TOP COATS OF QUICK DRY ENAMEL (BLACK)

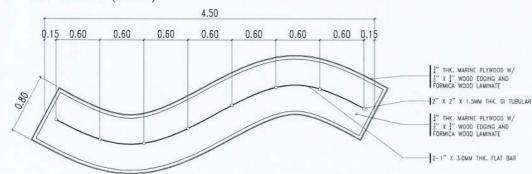

 $0.30\ \ 0.30$

1.60 3" THK, MARINE PLYWOOD W/

DECORATIVE PARTITION/BOOK SHELVES

DETAIL PLAN SCALE 1:50 MTS.

DECORATIVE PARTITION/BOOK SHELVES

PARTITION GRID PATTERN PLAN

SCALE 1:50 MTS.

DECORATIVE PARTITION/BOOK SHELVES

SCALE 1:50 MTS.



	PHOJEC
IVERSITY and	3
s 2300	PROJEC

REFURBISHMENT OF TSU MAIN CAMPUS LIBRARY CBA BUILDING, MAIN CAMPUS

ceers

REQUESTING OFFICE

MS. CYNTHIA M. BOGNOT

LIBRARY DIRECTOR

AR. MARK ANTHUM PUNZALAN

APPLIJECT PRINT




CHECKED BY


AR, CHERRY L. FABIANES

DR. GRACE N. ROSETE VP ADMIN AND FINANCE

RECOMMENDING APPROVA

SHEET CONTENTS: SHEET NO: A-15 AS SHOWN DR. ARNOLD E. VELASCO PAGE NO: 15/21

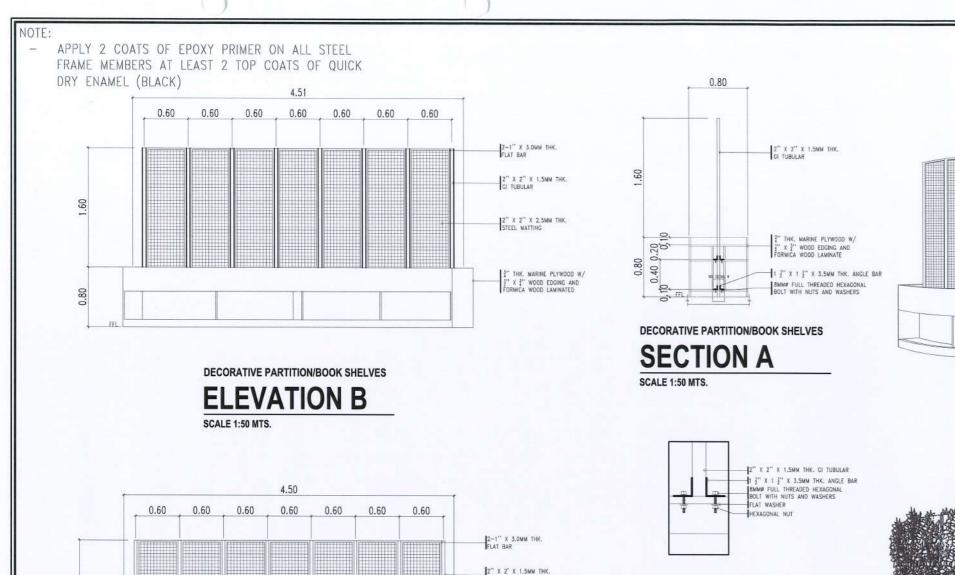


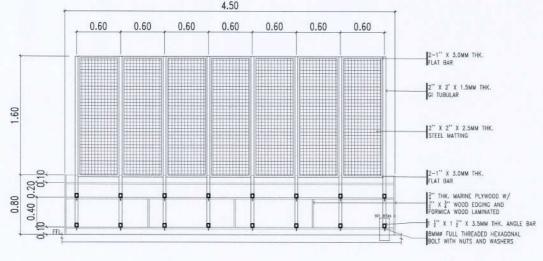

DECORATIVE PARTITION/BOOK SHELVES

SECTION B

SCALE 1:50 MTS.

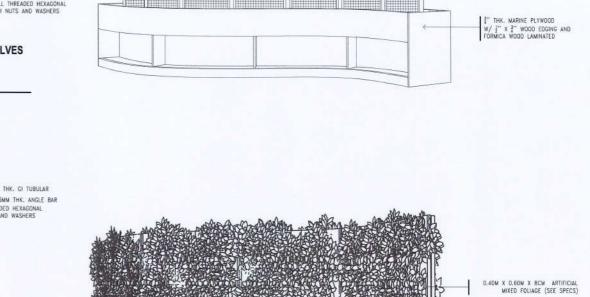

1]" X 1]" X 3.5MM THK. ANGLE BAR 18MM FULL THREADED HEXAGONAL BOLT WITH NUTS AND WASHERS FLAT WASHER HEXAGONAL NUT

DETAIL C SCALE 1:10 MTS.

DETAIL B

SCALE 1:10 MTS.

DECORATIVE PARTITION/BOOK SHELVES

ISOMETRIC DETAIL

RECOMMENDING APPROVA

SCALE 1:50 MTS.






REFURBISHMENT OF TSU MAIN CAMPUS LIBRARY PROJECT LOCATION:

CBA BUILDING, MAIN CAMPUS



REQUESTING OFFICE:

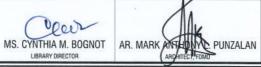

PREPARED BY:



CHECKED BY



en		
RRY L. FABIANES	DR. GRACE	.R
ECTOR, FDMO	VP ADMIN AND	FINA



	APPROVED:	SHEET CONTENTS:	SHEET NO:
	DR. ARMOLD E. VELASCO	AS SHOWN	A-16
		AO OHOWN	PAGE NO:
			16/21
	PRESIDENT	DATE:	10/21

2-1" X 3.0MM THK. FLAT BAR

2" X 2" X 3.5MM THK. STEEL MATTING

2" X 2" X 1.5MM THK. GI TUBULAR

GENERAL NOTES & SPECIFICATIONS

- ALL ELECTRICAL INSTALLATION HEREIN SHALL BE DONE IN ACCORDANCE WITH PROVISIONS OF THE LATEST EDITION OF PHILIPPINE ELECTRICAL CODE WITH THE RULES AND REGULATIONS OF THE NATIONAL AND LOCAL AUTHORITIES CONCERNED IN THE ENFORCEMENT OF ELECTRICAL LAWS AND ORDINANCES AND WITH THE REQUIREMENTS OF THE POWER COMPANY CONCERNED.
- 2. ALL ELECTRICAL WORKS HEREIN SHALL BE EXECUTED BY EXPERIENCED MEN UNDER THE SUPERVISION OF A DULY LICENSED REGISTERED MASTER ELECTRICIAN OR REGISTERED ELECTRICAL ENGINEER.
- 3. MATERIALS THAT PROVIDES SUPPORT, ADDED SAFETY, AND ACCESS, SUCH AS PULL BOXES, JUNCTION BOXES, BENDS AND OTHER FITTINGS SHALL BE PROVIDED EVEN IF NOT EXPLICITLY STATED IN THE PLAN.
- 4. THE ELECTRICAL SERVICE ENTRANCE POWER FOR THE BUILDING SHALL BE 230V, SINGLE PHASE, 2-WIRE + GROUND, 60 HZ. SEE SCHEDULE OF LOADS.
- 5. WIRES SHALL BE COLOR CODED AS FOLLOWS:

LINE 1 --- RED LINE 2 --- YELLOW GROUND --- GREEN

6. WIRING METHOD SHALL BE AS FOLLOWS: a. FOR EMBEDDED PIPE

FOR RUN EXPOSED PIPE

-POLYVINYL CHLORIDE CONDUIT SCHEDULE 40 (PVC SCH 40)

-ELECTRICAL METALLIC TUBING CONDUIT (EMT) -MICA TUBE, PVC FLEXIBLE HOSE OR PVC SCH 40


FOR DRYWALL


- 7. ALL MATERIALS TO BE USED SHALL BE BRAND NEW AND APPROVED TYPE FOR THE PARTICULAR LOCATION AND PURPOSE OF
- 8. ALL WIRES SHALL BE COPPER AND THERMOPLASTIC INSULATED TYPE "THHN" UNLESS OTHERWISE INDICATED IN THE PLAN. THE MINIMUM SIZE OF WIRE FOR POWER AND LIGHTING CIRCUIT SHALL BE 3.5mm. GROUNDING SYSTEM SHALL BE PROVIDED TO ALL EQUIPMENT PANEL BOARD AND NON-CURRENT CARRYING METAL IN ACCORDANCE WITH THE PHILIPPINE ELECTRICAL CODE REQUIREMENT.
- 10. ANY DISCREPANCY IN LOCATION AND RATING OF ELECTRICAL EQUIPMENT SHALL BE VERIFIED WITH THE OWNER AND CHANGES

ELECTRICAL SYMBOLS & LEGEND

Sa	One-gang One way Switch	Φ	Universal Duplex Convenience Outlet	DC	6U Data Cabinet with Tray
S _{ab}	Two-gang One way Switch	Фрс	Data Cabinet Duplex Universal Convenience Outlet	6 0	Battery-Operated Smoke Detector
S _{abc}	Three-gang One way Switch		Universal Duplex Convenience Outlet (Table Mounted)		Signage on Aluminum Composite Panel
0	20 Watts Recessed COB LED Round Downlight [Color: Daylight]	•	Airconditioner Convenience Outlet	DP-AVR	Branch Circuit Homerun
()	12 Watts Recessed COB LED Premium Directional Round Downlight [Color: Daylight]		Single CAT6 Lan Outlet (Ceiling Mounted)	EDP	Existing Distribution Panel Board
==)	2 - 18 Watts T8 LED Tube Light with Primastic Louver & Recessed Housing [Color: Daylight]	©	Duplex CAT6 Lan Outlet (Wall Mounted)	% 0	PVC Square Pull Box / PVC Junction Box
O EL	3 Watts Recessed LED Emergency Light [Ceiling Mounted]		Duplex CAT6 Lan Outlet (Table Mounted)	-	10° Wall Mounted Exhaust Fan
ED STRIP LIGHT	Outdoor SMD LED Striplight with Driver [Color: Warm White]]		PVC Flexible Conduit		PVC Pipe Conduit

MOUNTING DETAILS

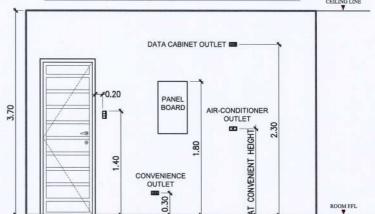

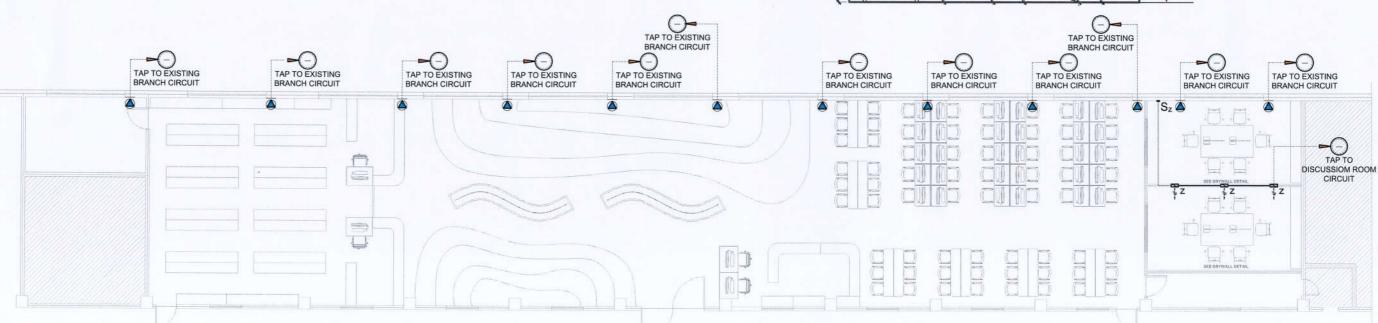

TSU MAIN LIBRARY AIR-CONDITIONING POWER LAYOUT

REFURBISHMENT OF TSU MAIN CAMPUS LIBRARY

SCALE

CBA BUILDING, MAIN CAMPUS

our MS. CYNTHIA M. BOGNOT

REQUESTING OFFICE

ENGR. ROVINGON F. FRIAS **ELECTRICAL ENGINEER**

AR. ARLEN M. GUIEB

CHECKED BY

AR. CHERRY L. FABIANES

DR. GRACE N. ROSETE VP ADMIN AND FINANCE

DR. ARMOLD E. VELASCO


SHEET CONTENTS: SHEET NO: E-01 AS SHOWN PAGE NO: 17/21





PROJECT TITLE:


PROJECT LOCATION:

PREPARED BY

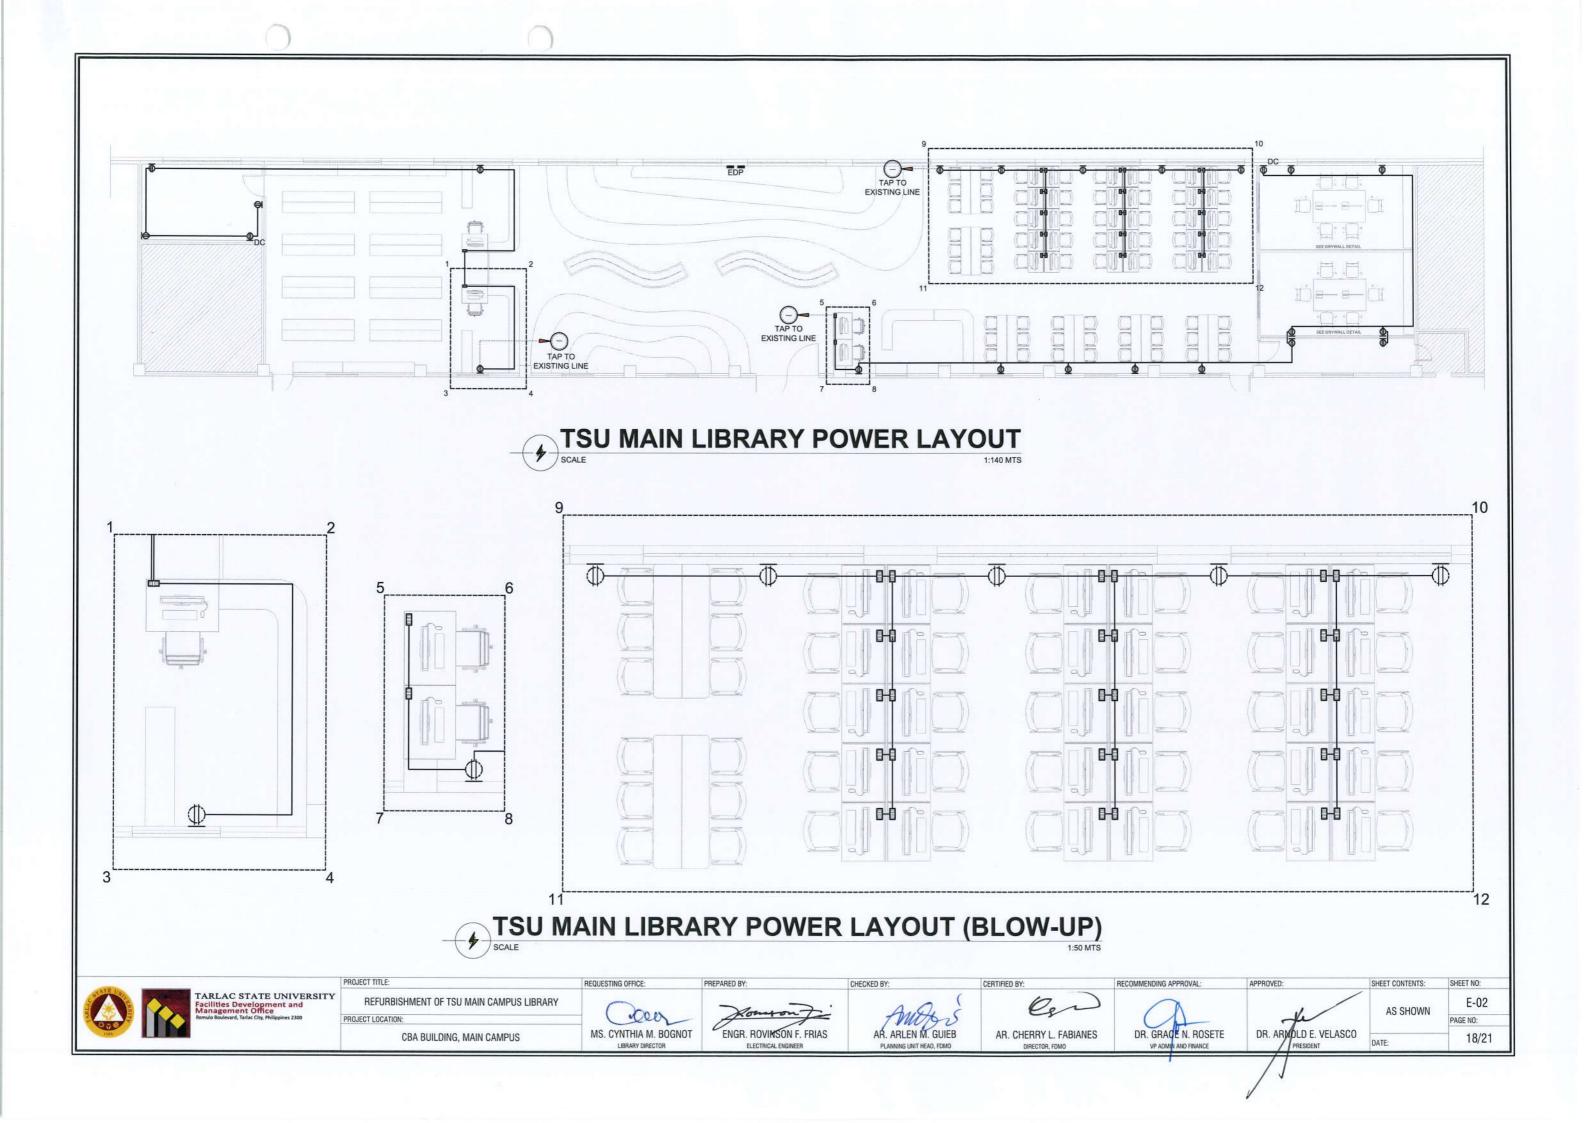


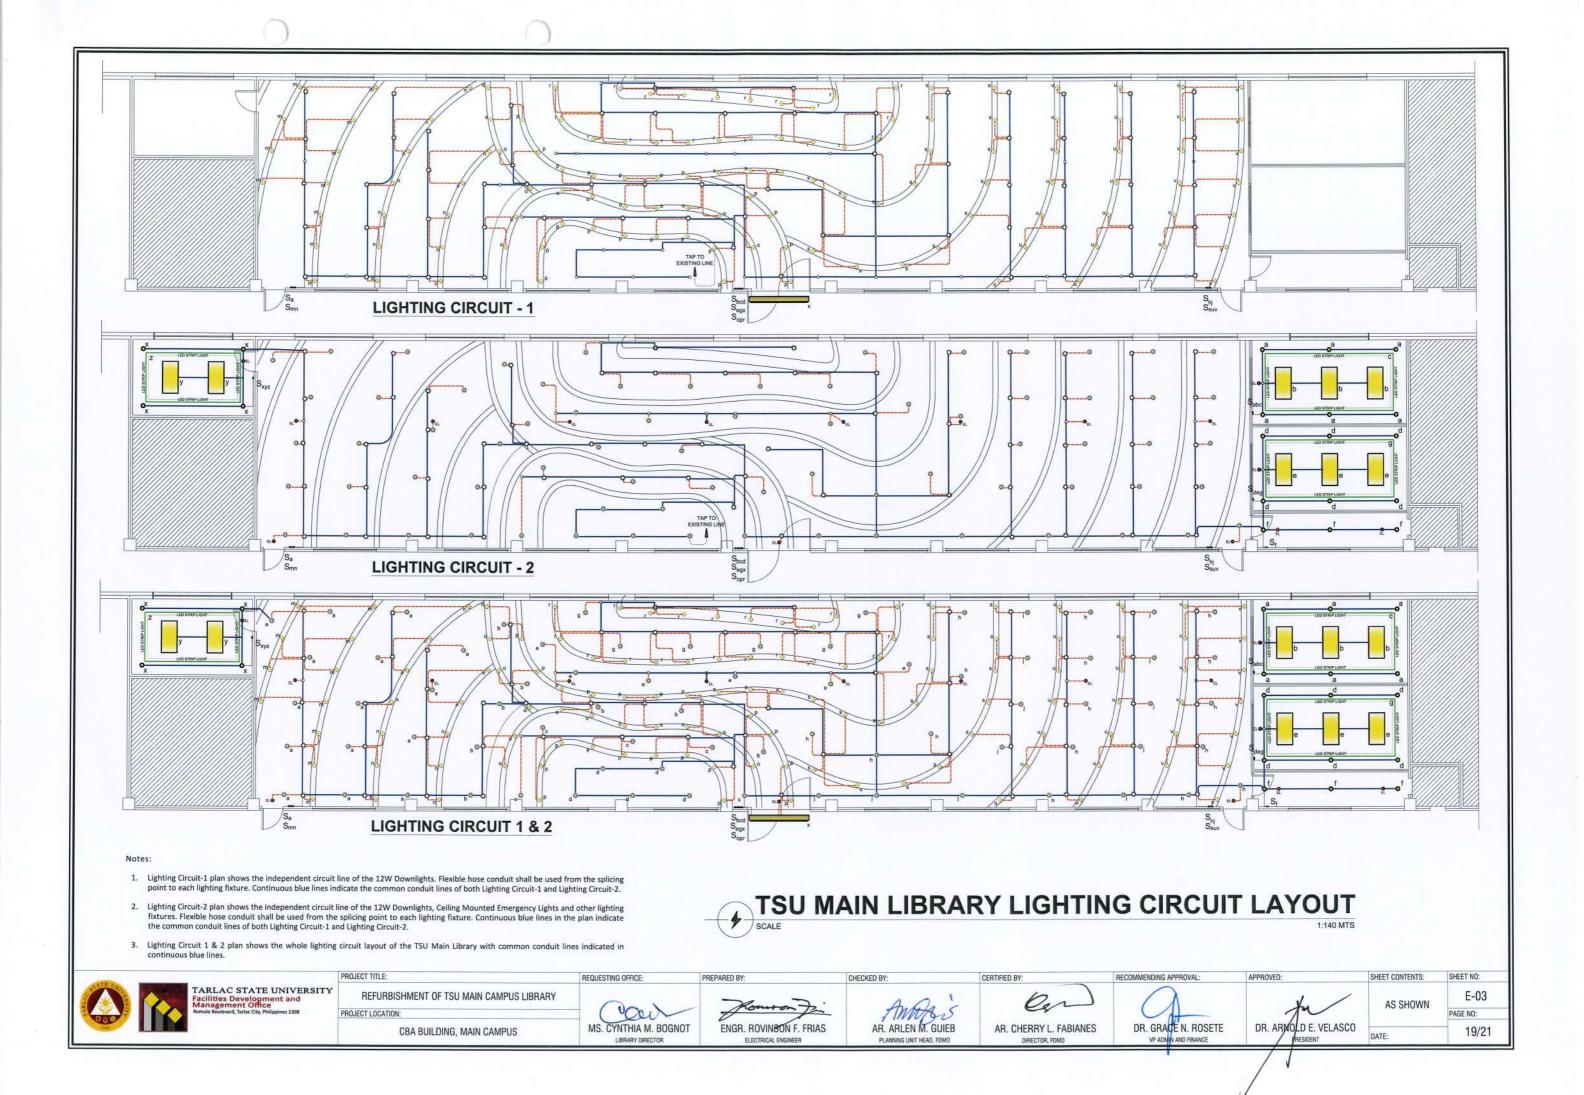

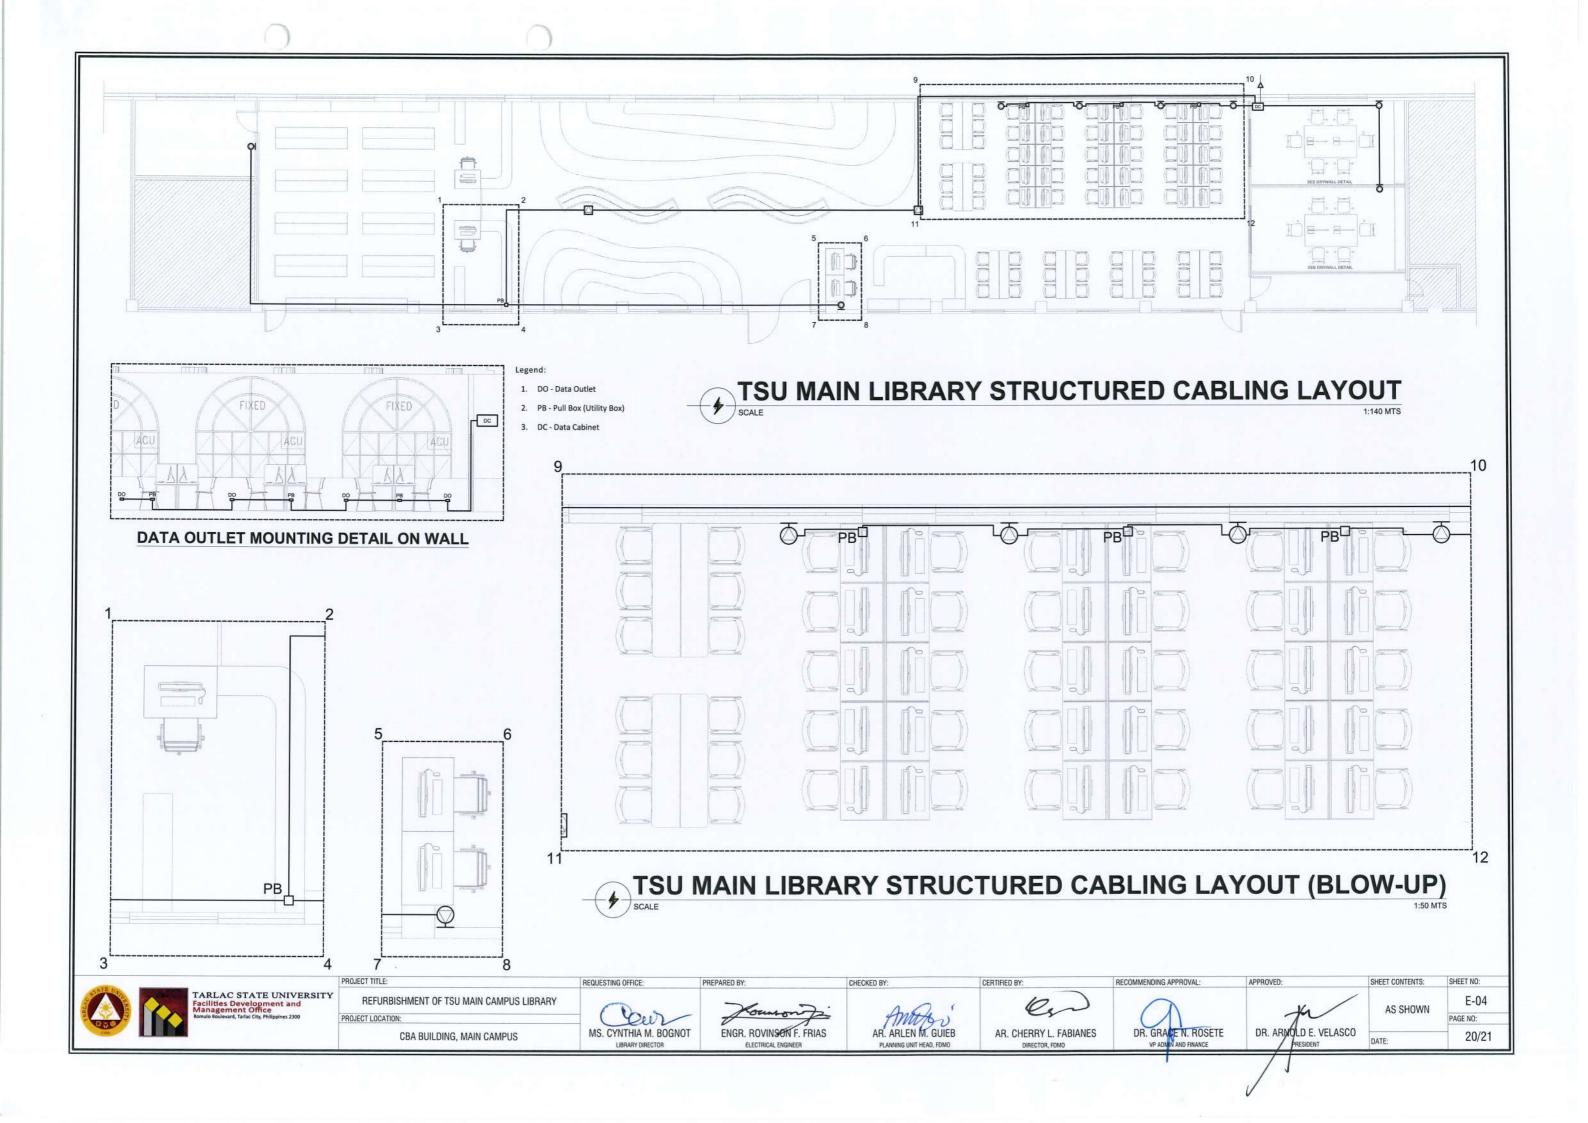

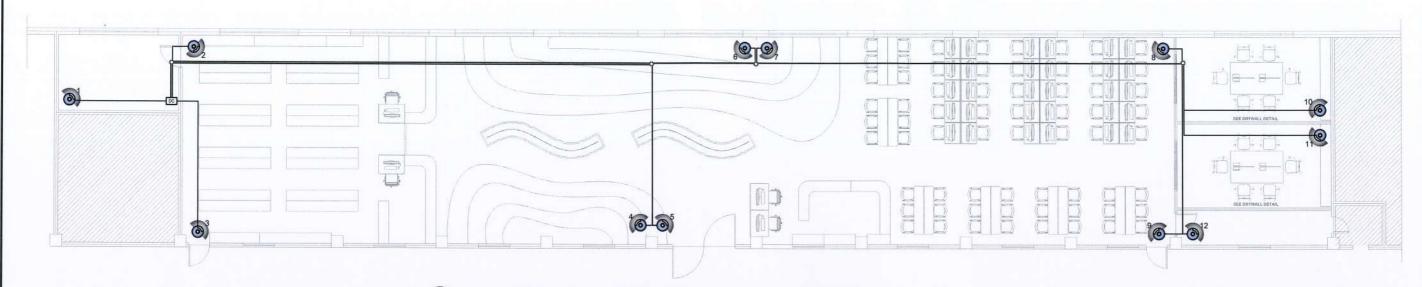


TSU MAIN LIBRARY CCTV LAYOUT

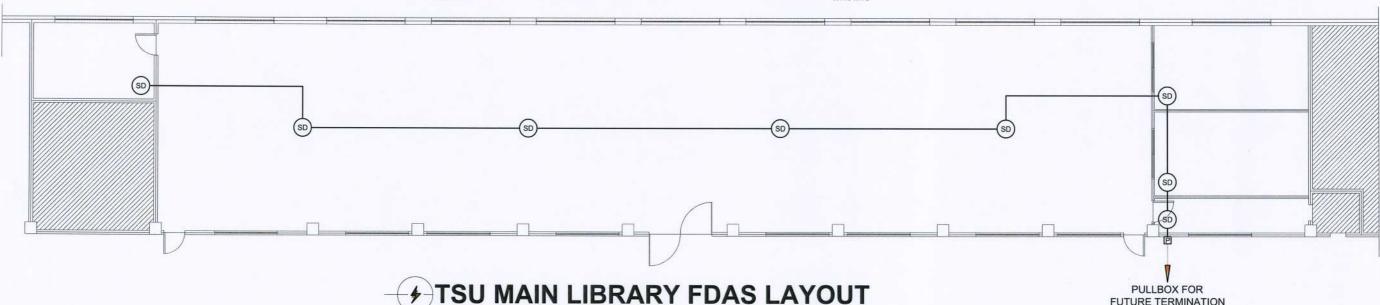

IMPORTANT NOTE: (STRUCTURED CABLING AND CCTV SYSTEM)

- 1. All equipments and cabling devices shall be unsupplied, hence, rough-ins shall be installed for all locations shown on the CCTV and structured cabling layouts for future installation the devices.
- 2. 3/4" dia. PVC pipe with G.I. wire inside shall be installed as a conduit for future installation of Category 6 cables.
- 3. 2" x 4" PVC utility box with blank plate shall be installed on the surface of the ceiling for future installation of cabling devices, equipments and future termination of Category 6 cables of structured cabling system.
- 3. 4" x 4" PVC junction box with cover shall be installed inside the ceiling for future installation of equipments and future termination of Category 6 cables of CCTV system.
- 4. 5" x 5" PVC square box shall be used as pullbox for future installation of Category 6 cables.

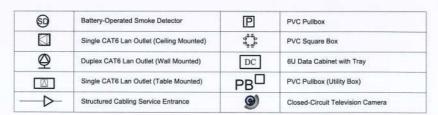

SYMBOLS & LEGEND

IMPORTANT NOTE: (FDAS)

1. 1/2" dia. PVC pipe with G.I. wire inside shall be installed as a conduit for future installation of Thermoplastic Fixture wire.

FUTURE TERMINATION

- 2. 2" x 4" PVC utility box with blank plate shall be installed on the surface of the ceiling for future installation of Thermoplastic Fixture wire and hard-wired smoke detectors.
- 3. 4" x 4" PVC junction box with cover shall be installed inside the ceiling for future installation of Thermoplastic Fixture wire and hard-wired smoke detectors.
- 4. 5" x 5" PVC square box shall be used as pullbox for future installation of Thermoplastic Fixture wire.





REFURBISHMENT OF TSU MAIN CAMPUS LIBRARY PROJECT LOCATION: CBA BUILDING, MAIN CAMPUS

Lew MS. CYNTHIA M. BOGNOT

REQUESTING OFFICE:

ENGR. ROVINSON F. FRIAS ELECTRICAL ENGINEER

PREPARED BY

AR, ARLEN M. GUIEB PLANNING UNIT HEAD, FDMO

CHECKED BY:

AR, CHERRY L. FABIANES DIRECTOR, FDMO

DR. GRACEN, ROSETE VP ADMIN AND FINANCE

RECOMMENDING APPROVAL

DR. ARNOLD E. VELASCO

SHEET CONTENTS: SHEET NO: E-05 AS SHOWN PAGE NO: 21/21